

NORTH ELEVATION



EAST ELEVATION



SOUTH ELEVATION



WEST ELEVATION



MAIN ENTRANCE, WEST FACE OF BUILDING


PIC. 1



CORNER COLUMN

PIC. 3

WHAT PLACES THE BUILDING IN NEO-CLASSICAL IS THE ANTIQUE DETAILED MOULDINGS FOUND AROUND THE DOORS AND WINDOWS IN THE INTERIOR. IT IS FOR THIS REASON THAT I CHOSE TO DO DETAILS OF THE MOULDINGS. THE OLD ENTRY ALSO APPEARS TO HAVE A BROAD FLAT-HEADED TRANSOM OVER THE DOOR. EVEN THE EXPRESSIONAL PRESENTATION OF THE STRUCTURE, SEEN AT THE EDGES OF THE BUILDING BY THE DETAILED COLUMNS(see pic. 3), EXPRESS THE IDEA OF NEO-CLASSICAL STYLE THAT THE BUILDING SHOULD CONSIST SOLELY OF THE ELEMENTS THAT SUPPORT THE BUILDING.

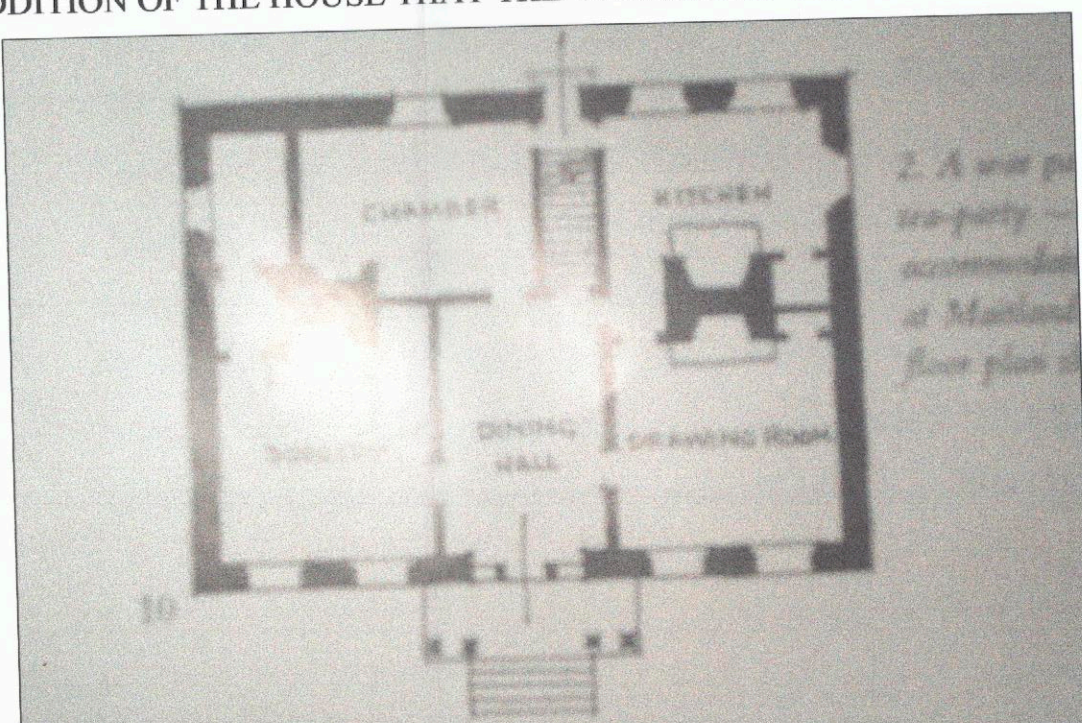

REGENCY FLOOR PLAN

PIC. 4

THIS NEO-CLASSICAL/REGENCY HOUSE IS LOCATED AT 1075 GORHAM ST. IN NEWMARKET ONTARIO AND IS OWNED BY TONY DREW. AS A RESULT OF THE UNKNOWN CONSTRUCTION DATE OF THE BUILDING, IT MAKES IDENTIFYING THE ARCHITECT OF THE HOUSE IMPOSSIBLE. WHAT IS SUSPECTED IS THE ORIGINAL OWNER OF THE BUILDING WAS A CARPENTER AND BUILT THE HOUSE USING THE REGENCY STYLE. THE BUILDING HAS GONE THROUGH MANY RENOVATIONS, AND AS A RESULT HAS ALTERED THE ORIGINAL FLOOR PLAN TO WHAT THEY ARE TODAY. FOR EXAMPLE DURING A RENOVATION THE FRONT ENTRY WAS REMOVED AND FILLED IN WITH A WINDOW (see pic.2), CAUSING THE WEST SIDE OF THE HOUSE TO BECOME THE NEW ENTRY(see pic.1).


THE HOUSE CAN BE PLACED IN BOTH NEO-CLASSICAL AND REGENCY BECAUSE OF THE TYPICAL DETAILS USED IN BOTH STYLES FOUND ON THE BUILDING. THE CHARACTERISTIC STYLES OF REGENCY FOUND ON THIS HOUSE IS FOUND IN THE SYMMETRICAL SQUARE SHAPED FLOOR PLAN (see pic. 4) AND HIP ROOF. TYPICALLY REGENCY STYLE BUILDINGS HAVE A VERANDAH. IT IS POSSIBLE THAT DURING A RENOVATION AND/OR ADDITION OF THE HOUSE THAT THE VERANDAH WAS REMOVED.




LIVING ROOM WINDOW



LIVING ROOM TO OLD ENTRY DOOR WAY

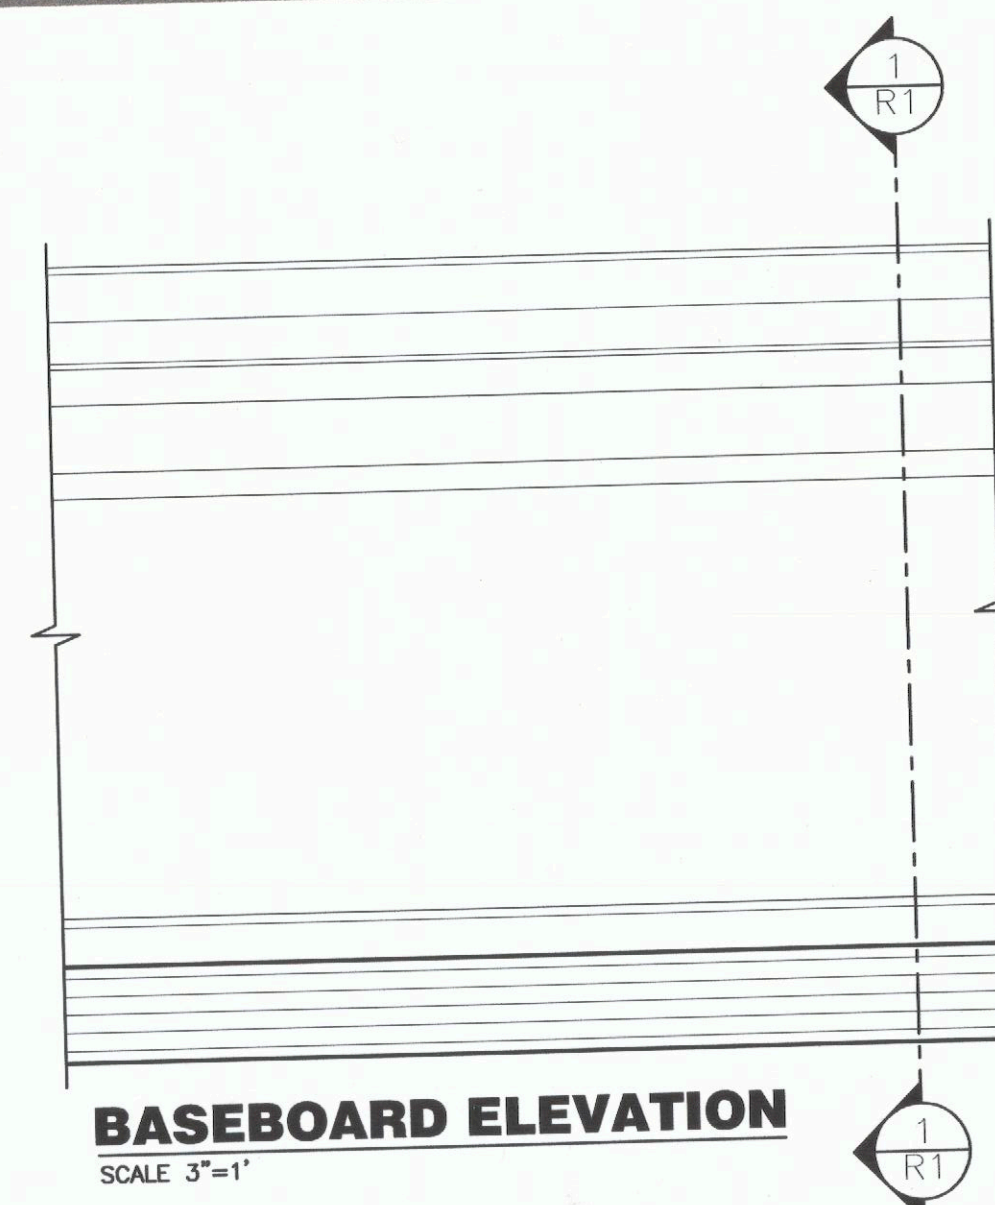

BASEBOARD ELEVATION
SCALE 3"=1"

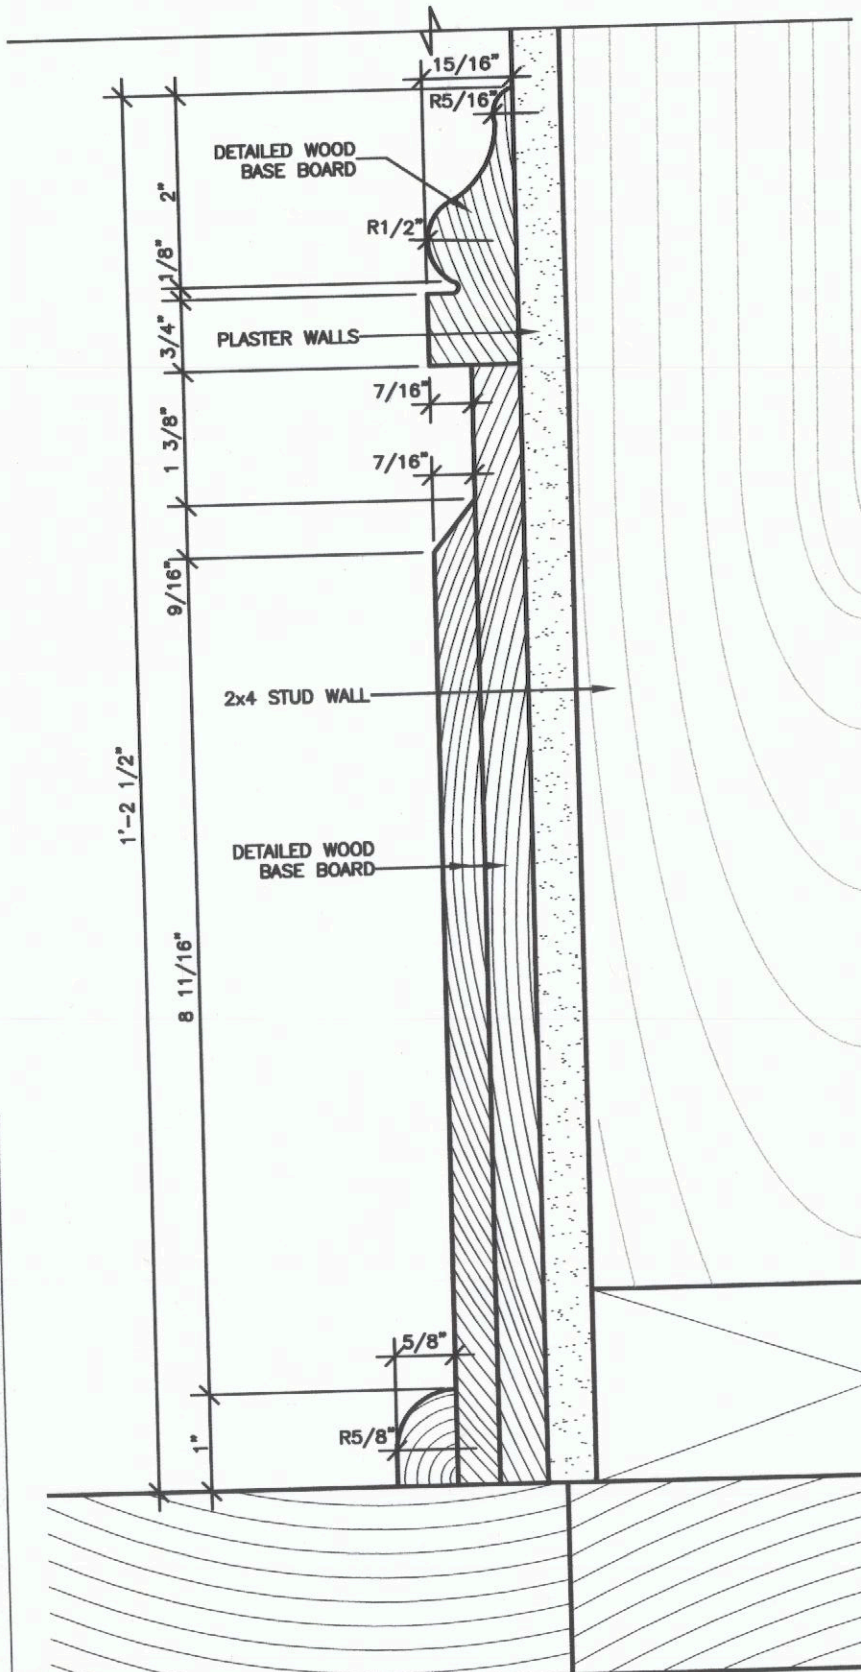


BASEBOARD SECTION
SCALE 6"=1"



BASEBOARD
NOT SCALED




WINDOW JAMB
NOTE SCALED

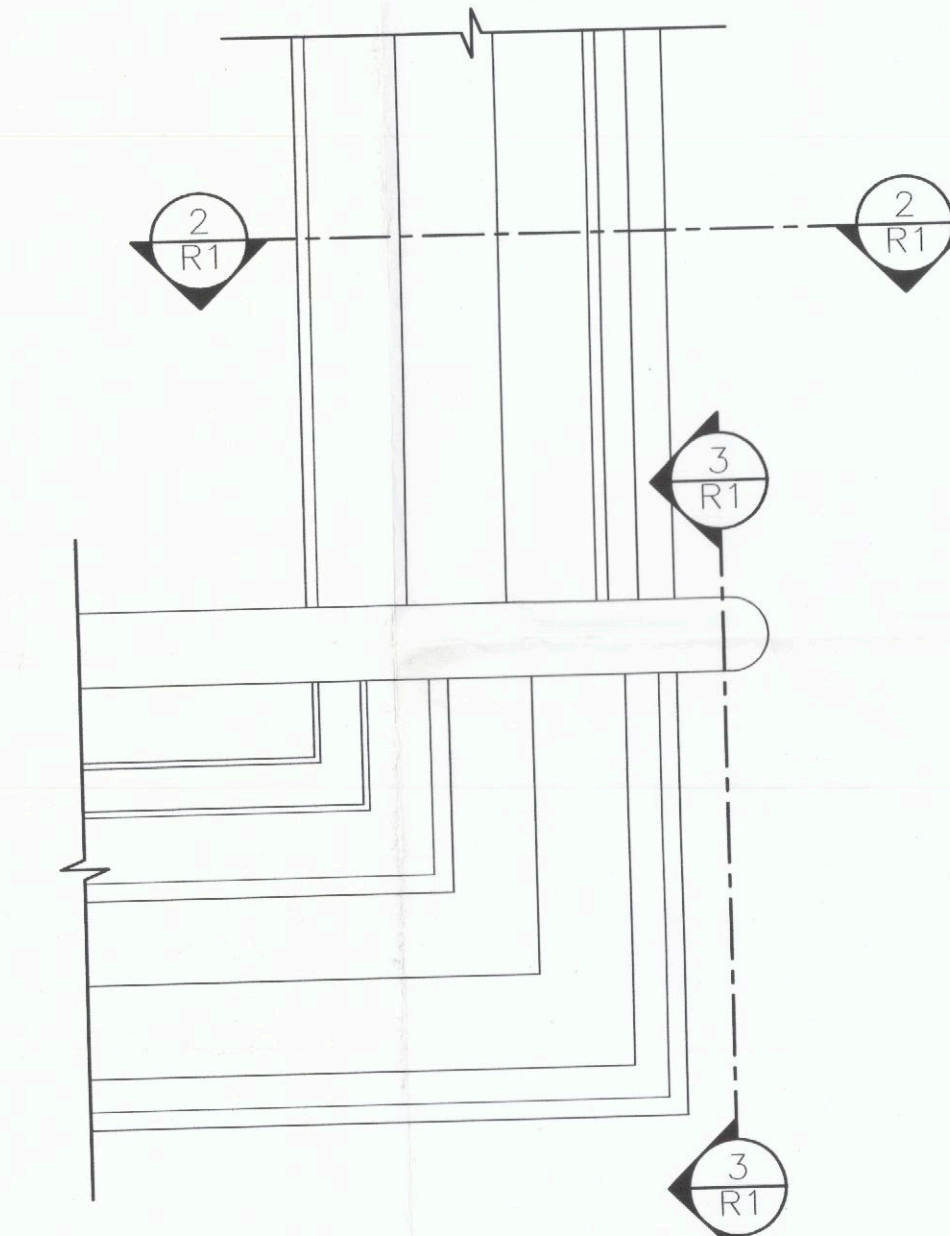


WINDOW JAMB/SILL ELEVATION
SCALE 3"=1"



WINDOW SILL AND TRIM
NOT SCALED

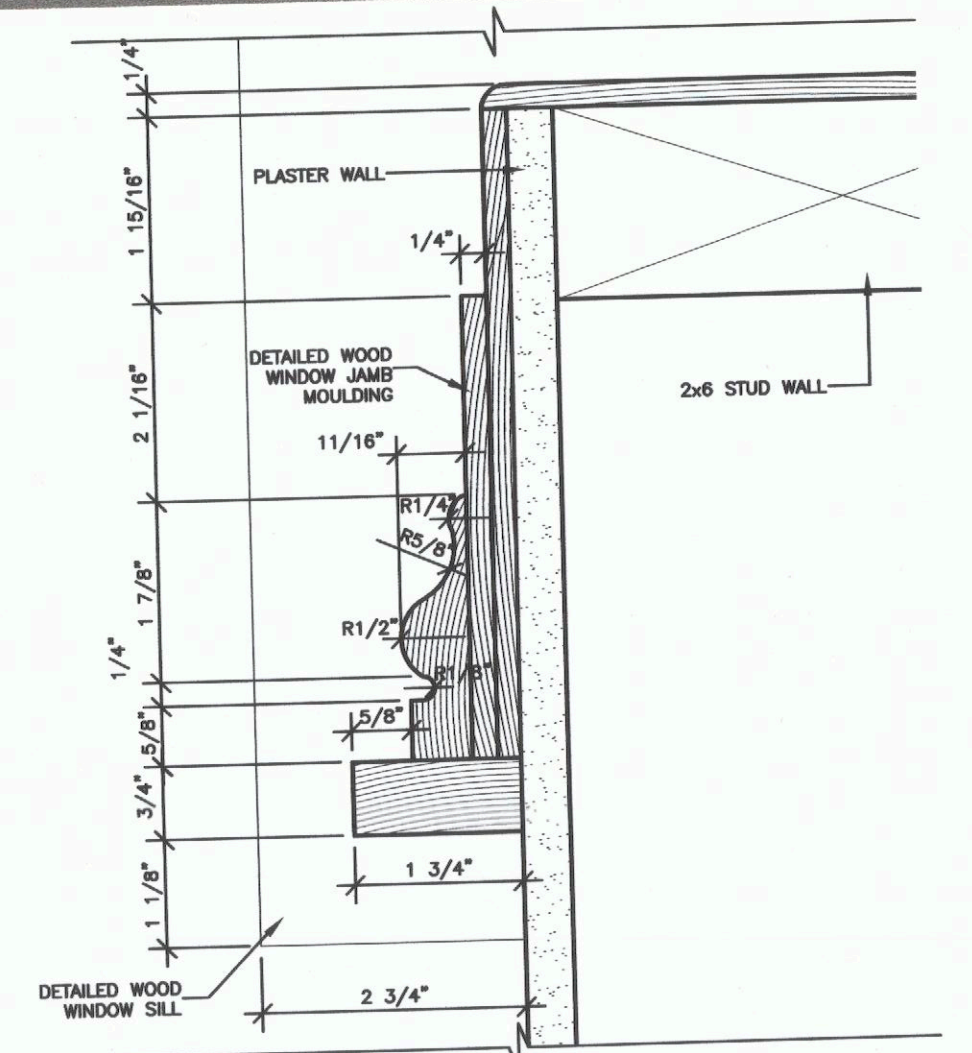

WINDOW JAMB SECTION
SCALE 6"=1"

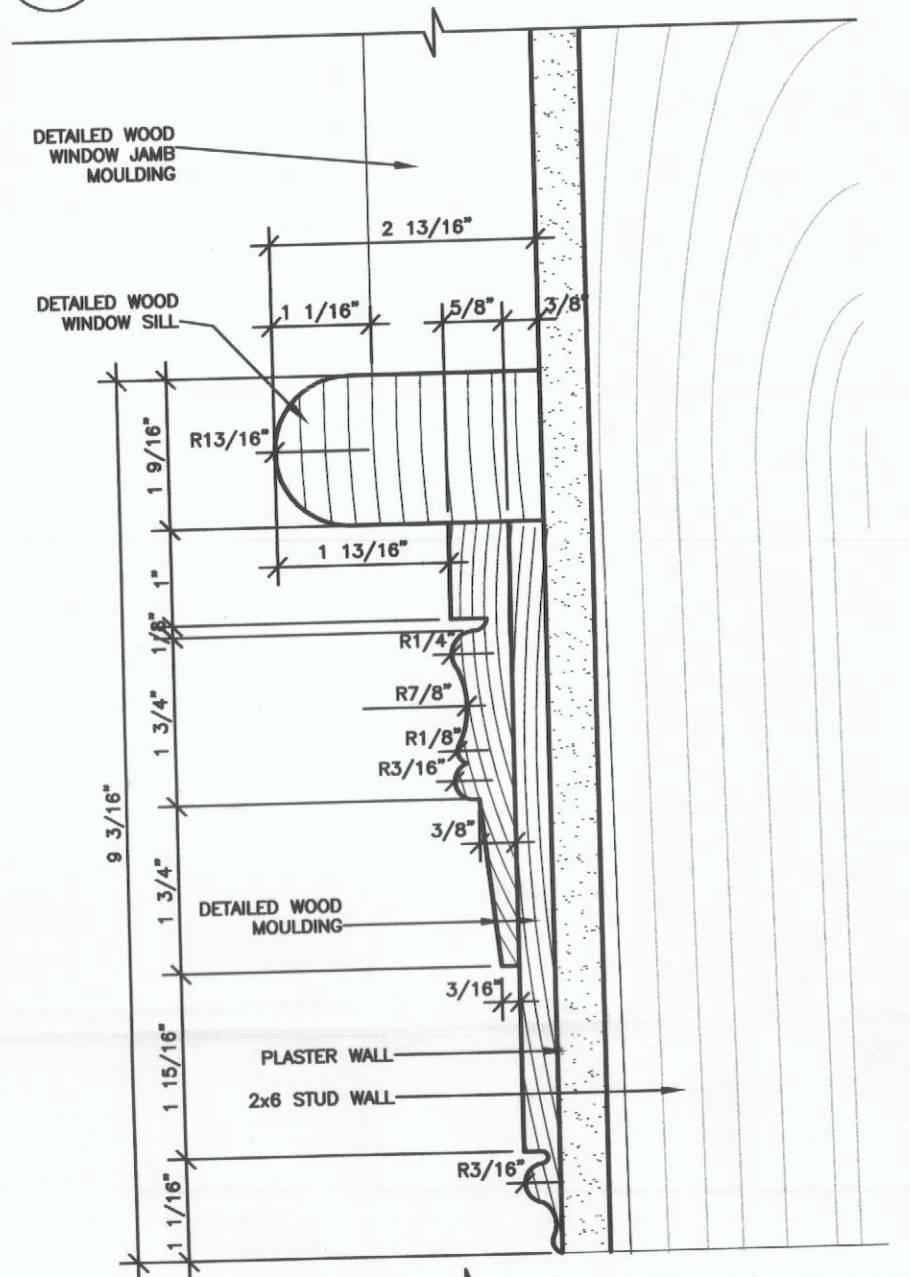

WINDOW SILL SECTION
SCALE 6"=1"



CLIENT
TONY DREW

PROJECT TITLE
BUILDING DETAILS OF NINETEENTH CENTURY HOUSE
NEWMARKET ONTARIO

DRAWING TITLE
WINDOW SILL, JAMB AND BASEBOARD DETAILS

SCALE AS NOTED DATE PLOTTED OCT 2 2002
DATE 2 OCT 2002 CAD. DRAWING PROJECT 2
DRN BY DAVE FINLEY DRAWING No **R1**